
FIRST CONGREGATIONAL CHURCH

1511 CHURCH STREET WAUWATOSA, WI 53213

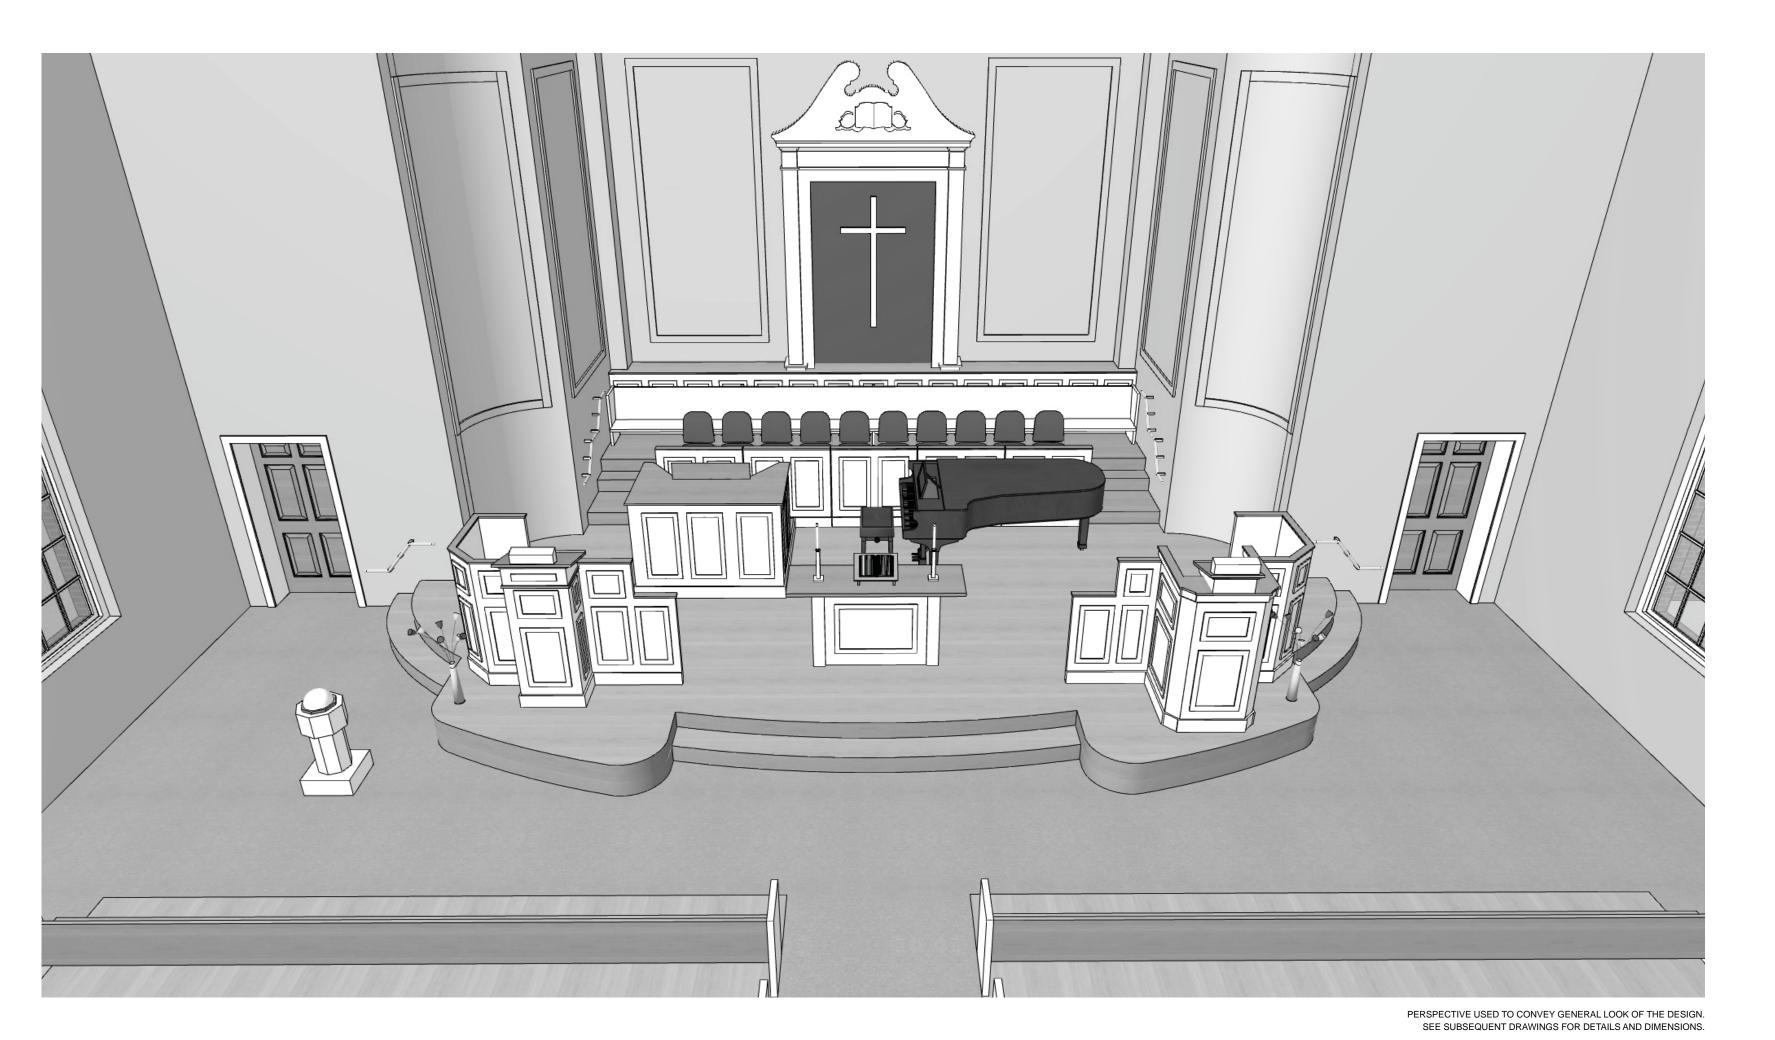

CONTACT INFORMATION

OWNER:

FIRST CONGREGATIONAL CHURCH 1511 CHURCH STREET WAUWATOSA, WI 53213

GALBRAITH CARNAHAN ARCHITECTS 6528 WEST NORTH AVENUE MILWAUKEE, WI 53213 [414] 291-0772

> CONTACT: BRANDON REINKE bmr@galbraithcarnahan.com

ABBREVIATIONS

Acoustic Ceiling Tile Area Drain Above Finished Floo ALUM Aluminum ANOD Anodized APPROX Approximately BES BLKG BLKHD BRG BSMT BT Bank Equipment Supplie Blocking Bulkhead Bearing Basement Base Tile Beyond Bottom Of Bottom Cabinet
Cast In Place
Channel
Control Joint
Closet
Ceiling
Clear
Construction Manager CM Construction Ma
CMU Concrete Mason
COL Column
COMPR Compressible
CONC Concrete
CONC BLK Concrete Block
CONT Continuous
CONTR Contractor
CPT Carpet
CRS Course
CT Ceramic Tile Concrete Masonry Unit

Course Ceramic Tile Ceramic Tile Base

DBL
DEMO
DIA
DIM
DIMS
DISP
DN
DR Demolish or Demolition Diameter Dimension
Dimensions
Dispenser
Down
Door Drawer Downspout Detail Dishwasher Drawing Exterior Insulation Finish System Expansion Joint Elevator or Elevation Ethylene Propylene Diene M-Class (Roofing) EQ ETR EXIST EXP EXP JT EXT Existing To Remain Expansion Joint Floor Drain or Fire Departmen Fire Extinguisher Fire Extinguisher Cabinet

Filled Metal Face Of

Gauge Galvanized Grab Bar Gypsum Wall Board H
HC Hollow Core
HDWD Hardwood
HDR Header
HI High
HM Hollow Metal
HORIZ Horizontal
HP High Point Horizontal
High Point
Hour
Height HRDBD Hardboard HVAC Heating, Ventilating, And Air Conditioning IRGWB Impact Resistant Gypsum Wall Board In Lieu Of Instructions Insulated or Insulation Manufacturer Masonry Opening Mechanical MEMBR Membrane MICRO Microwave Miscellaneous Moisture Resistant Dry Wall MRGWB Moisture-Resistant Gypsum Wall Board

MAX MFR MO MECH Manufacturer Masonry Opening MECH Mechanical MEMBR Membrane MICRO Microwave
MIN Minimum
MISC Miscellaneous
MRDW Moisture Resistant Dry Wall MRGWB Moisture-Resistant Gypsum Wall Board Metal Mortar Not In Contract Nominal Opposite Hand Opening Ounce Pre-Cast Concrete PLUMB Plumbing
PLAM Plastic Laminate
PLUMB Plumbing PLUMB Plumbing
PLYWD Plywood
P&SH Pole & Shelves / Shelf Pressure Treated Paint or Painted

Rubber Reflected Ceiling Plan

Refrigerator

Required Room Sheathing Sheet Flooring Specified OR Specification Sprinkler or Speaker Stainless Steel Sound Transmission Coefficient Steel STL STRUCT Structure or Structural Tongue And Groove
Telephone
Toilet
Top Of
Top Of Concrete
Top Of Steel
Toilet Paper Dispenser Telephone/Data Underside Vinyl Composition Tile Vertical Verify In Field Vision Panel Vinyl Wall Covering Wood Window

SYMBOL KEY — - — - — (A) DOOR NUMBER - SEE DOOR SCHEDULE SEE STRUCTURAL DRAWINGS. WINDOW TYPE - SEE WINDOW SCHEDULE **ROOM** ROOM NAME & NUMBER **ELEVATION TAG** NEW DOOR - SEE DOOR SCHEDULE SECTION TAG EXISTING DOOR - SEE DOOR SCHEDULE DRAWING TITLE I.E. ELEVATION ON SHEET A400 DETAILS 1, 2, 3, 4 I.E. DETAIL 1 ON SHEET A500 WALL TAG + 8'-0" T.O. FOUND. = SPOT ELEVATION MARKER HEIGHT TAG

SHEET INDEX

G100 COVER SHEET AD100 DEMOLITION PLAN A100 FLOOR PLAN A300 OVERVIEW AND SECTION


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1511 CHUR WAUWATOS

DRAWING ISSUE PRICING SET

PROJECT# 17.08 **COVER SHEET**

6528 West North Avenue Milwaukee, Wisconsin 53213 (414) 291-0772 phone www.galbraithcarnahan.com

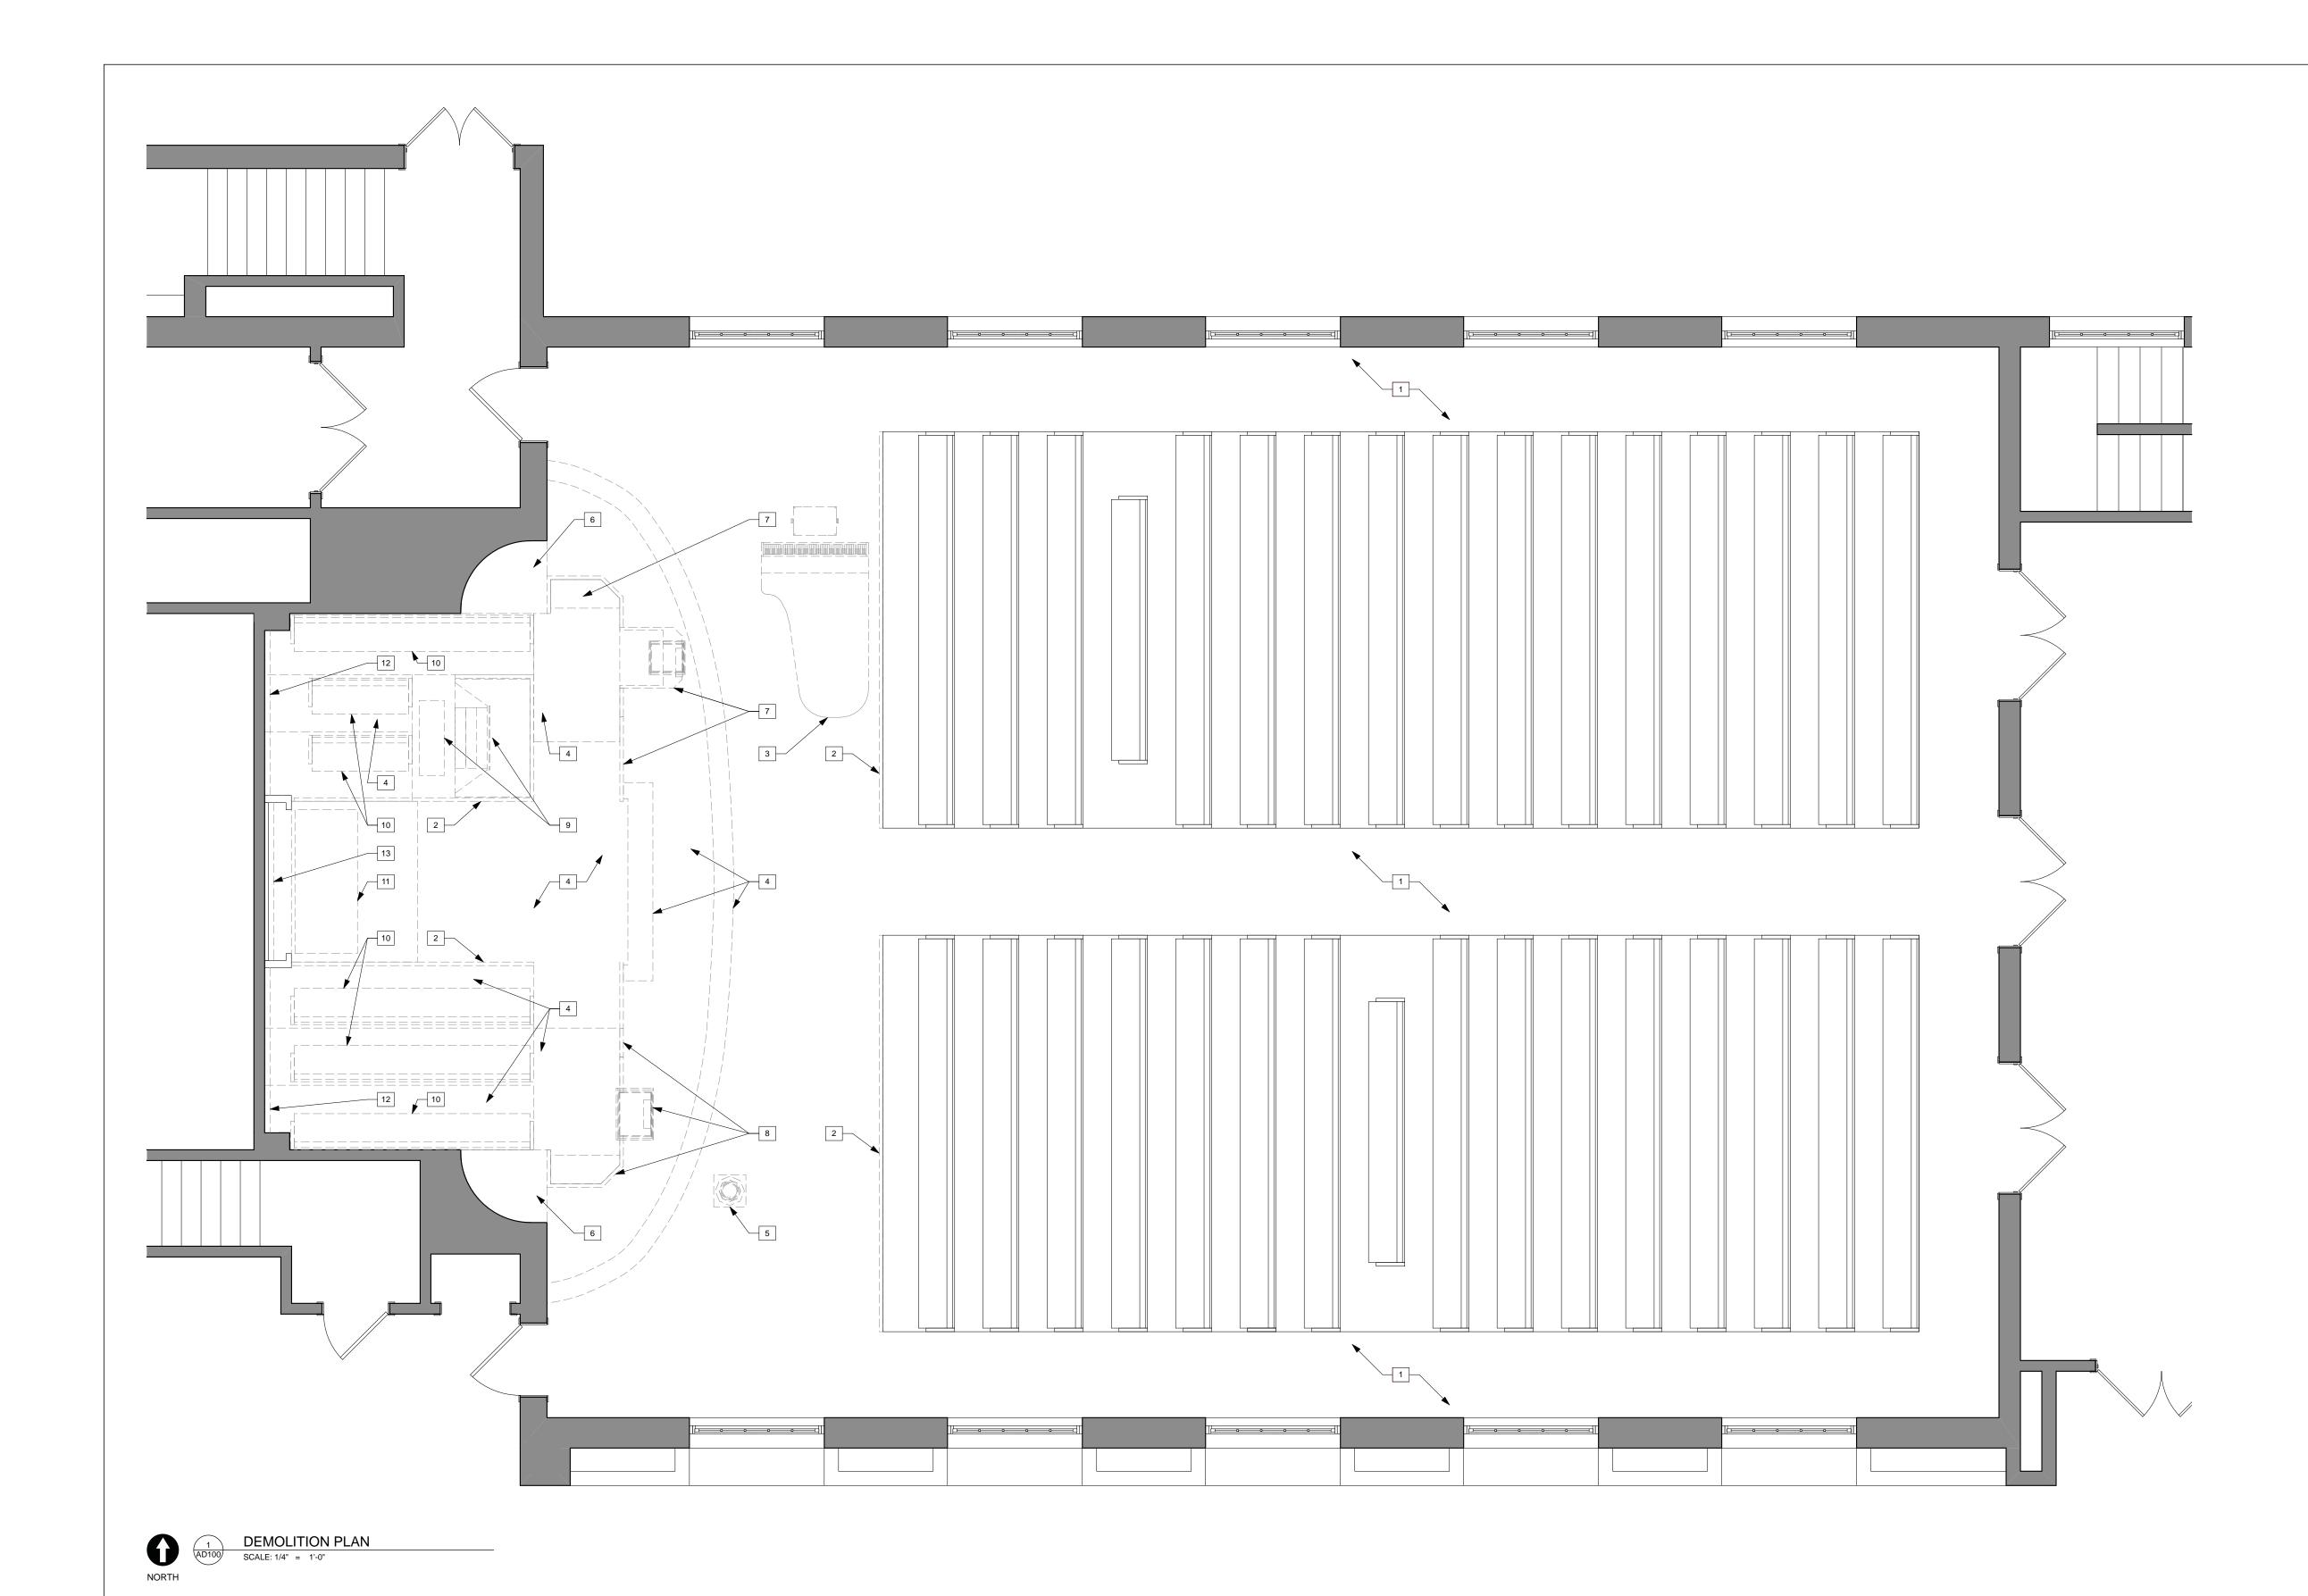

DEMOLITION PLAN KEY NOTES

- EXISTING CARPET FLOOR COVERING AND REMAINING ADHESIVE TO BE REMOVED. PREP EXISTING SUB-FLOOR FOR ACCEPTANCE OF NEW FLOORING MATERIAL.
- 2 EXISTING MODESTY WALL PANELS TO BE REMOVED.
- 3 EXISTING PIANO TO BE REMOVED AND RELOCATED PER NEW CHANCEL LAYOUT.
- 4 EXISTING WOOD PLATFORM STRUCTURE TO BE REMOVED.
- EXISTING PULPIT, PASTORAL BENCH, AND SURROUNDING MODESTY WALL PANELS TO
- 8 EXISTING LECTERN, PASTORAL BENCH, AND SURROUNDING MODESTY WALL PANELS TO BE REMOVED AND SALVAGED PER NEW CHANCEL LAYOUT.

- 12 EXISTING ACOUSTICAL FABRIC AND WOOD TRIM TO BE REMOVED.
- 13 EXISTING FABRIC CURTAIN TO BE REMOVED.

DEMOLITION - GENERAL NOTES

- IF ANY PORTION OF THE CONSTRUCTION DOCUMENTS ARE UNCLEAR, INCOMPLETE IN THEIR DIRECTION, OR CONFLICTS WITH OTHER PORTIONS OF THE WORK; PLEASE NOTIFY THE ARCHITECT PRIOR TO EXECUTING THAT WORK.
- 2. PROVIDE DEMOLITION WORK SHOWN ON THE DRAWINGS AND RELATED AND INCIDENTAL DEMOLITION WORK REQUIRED TO COMPLETE NEW CONSTRUCTION

- PROTECT EXISTING CONSTRUCTION TO REMAIN FROM DAMAGE DURING DEMOLITION AND / OR NEW CONSTRUCTION OPERATIONS. CONDUCT DEMOLITION OPERATIONS SO AS TO MINIMIZE THE DEVELOPMENT AND SPREAD OF DUST.
- OFF SITE.
- DO NOT ALTER THE STRUCTURAL INTEGRITY OF THE EXISTING BUILDING OR IT'S ASSEMBLIES UNLESS SPECIFICALLY NOTED OTHERWISE.
- 8. IN WALLS TO BE REFINISHED, REMOVE EXISTING MISCELLANEOUS ACCESSORIES TO FACILITATE THE INSTALLATION OF NEW FINISHES. PATCH, REPAIR, AND PREP WALLS TO RECEIVE NEW FINISHES. ITEMS REMOVED TO BE SALVAGED AND GIVEN BACK TO
- 9. REMOVE ALL WALL CONDUITS LEFT AFTER WALL DEMOLITION INCLUDING SWITCH BOXES, PLATES, BRIDGES, PLUMBING LINES, OR ANY OTHER TELEPHONE OR ELECTRICAL WIRING AND EQUIPMENT. DEMOLISHED LINES ARE TO BE BROUGHT BACK TO PANELS, RISERS, ETC. AND DISCONNECTED OR CAPPED.
- 10. SALVAGE ALL DEMOLISHED ITEMS OF HISTORICAL OR ARCHITECTURAL SIGNIFICANCE. I.E. DOORS, WINDOWS, TRIM, CASING, OLD GROWTH FRAMING & DECKING, FLOORING,

- EXISTING BAPTISMAL FONT TO BE REMOVED AND RELOCATED PER NEW CHANCEL LAYOUT.
- 6 EXISTING HALF HEIGHT WALL STRUCTURE AND WOOD TRIM CAP TO BE REMOVED.
- BE REMOVED AND SALVAGED PER NEW CHANCEL LAYOUT.
- 9 EXISTING ORGAN TO BE REMOVED AND RELOCATED PER NEW CHANCEL LAYOUT.
- EXISTING WOOD CHOIR PEWS TO BE REMOVED AND SALVAGED PER NEW CHANCEL LAYOUT.
- 11 EXISTING ALTAR TO BE REMOVED AND SALVAGED PER NEW CHANCEL LAYOUT.

- 3. REMOVE ENTIRE WALL ASSEMBLY INDICATED TO BE DEMOLISHED, INCLUDING CONCEALED ELEMENTS WITHIN THE PARTITIONS AND ABOVE CEILING CONSTRUCTION [UNO].

- 5. REMOVE DEMOLITION MATERIALS FROM SITE PROMPTLY AND DISPOSE OF LEGALLY
- 7. UPON REMOVAL OF FINISH MATERIALS INDICATED, PREPARE SUBSTRATE TO RECEIVE NEW FINISH. REFER ALSO TO ROOM FINISH SCHEDULE FOR NEW MATERIALS. REPAIR ANY EXISTING DAMAGE OR DAMAGE ARISING FROM DEMOLITION OPERATIONS TO MATCH EXISTING AND AS NEEDED FOR INSTALLATION OF NEW FINISHES.


DEMOLITION PLAN

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PRICING SET

PROJECT#

17.08

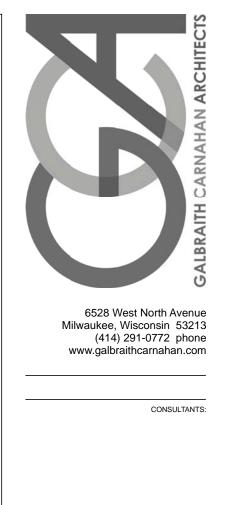

WALL TYPE LEGEND

NEW WALL EXISTING WALL TO REMAIN

FLOOR PLAN - GENERAL NOTES

IF ANY PORTION OF THE CONSTRUCTION DOCUMENTS ARE UNCLEAR, INCOMPLETE IN THEIR DIRECTION, OR CONFLICTS WITH OTHER PORTIONS OF THE WORK; PLEASE NOTIFY THE ARCHITECT PRIOR TO EXECUTING THAT WORK.

NOTIFY ARCHITECT PROMPTLY IF THE CONSTRUCTION DOCUMENTS ARE INCONSISTENT WITH ANY APPLICABLE CODES OR REGULATIONS.

3. INSTALL BLOCKING IN WALLS, CEILING AND FLOORS AS REQUIRED FOR THE ATTACHMENT OF ANY ITEMS OR EQUIPMENT SHOWN IN THE CONSTRUCTION DOCUMENTS.

4. REFER TO STRUCTURAL PLANS, FOR FRAMING SIZE, AND ORIENTATION.

5. CONTRACTOR TO VERIFY ALL DIMENSIONS IN FIELD PRIOR TO EXECUTION OF WORK.

6. TYPICAL FLOOR PLAN DIMENSIONS ARE SHOWN TO THE EXTERIOR FACE OF WALLS, UNLESS NOTED OTHERWISE.

7. COORDINATE EXACT LOCATION OF LIGHT FIXTURES, ACCESS PANELS, SPEAKERS, HVAC DUCTS, GRILLS, DIFFUSERS AND OTHER SUCH CEILING ITEMS WITH MECHANICAL, ELECTRICAL, AND OTHER PERTINENT TRADES. NOTIFY ARCHITECT IF ANY LOCATIONS OR CONDITIONS CONFLICT WITH THE DESIGN INTENT SHOWN IN THESE CONSTRUCTION DOCUMENTS.

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05.10.17

17.08

FLOOR PLAN

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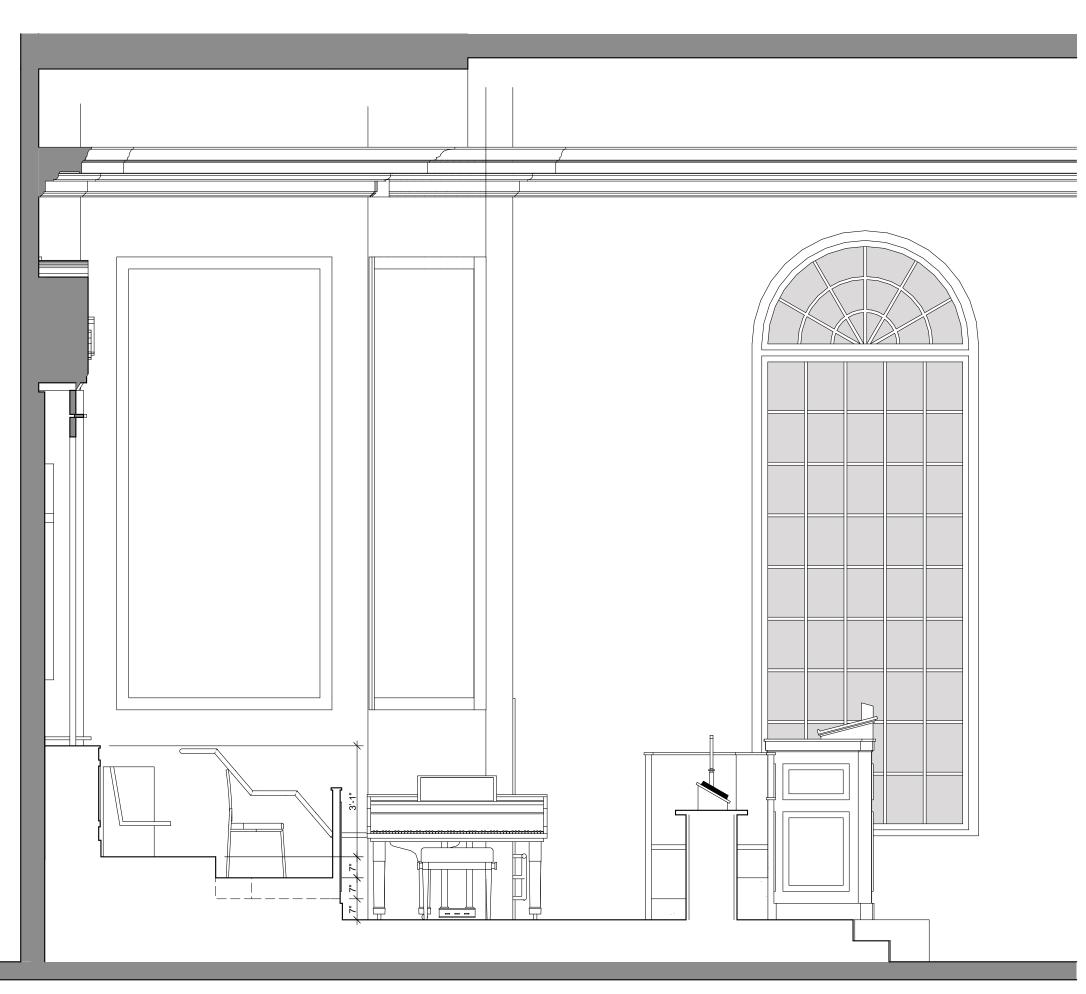
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OVERVIEW AND

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CHANCEL OVERVIEW - TYPICAL SUNDAY

SCALE: 1:65.28